VERISTONE 1 ISSAQUAH

SW 1/4 OF NW 1/4 OF SECTION 28, T. 24 N., R. 06 E., W.M. CITY OF ISSAQUAH, STATE OF WASHINGTON

DEM18-0005

FOUND MONUMENT IN CASE

SDCB RIM=163.28 IE 24" CMP (E)=150.18 IE 6" ADS (SW)=158.68 IE 21" CMP (W)=150.18

NW INNESWOOD DRIVE

30' ROAD EASEMENT

TO BE RELINQUISHED

LOT 43 THE WOODS AT ISSAQUAH DIVISION 1 VOL. 110, PGS. 31–33

- REC. NO. 4921/218

N8816'54"W 270.00' (P) 269.89' (M)



THAT PORTION OF THE SOUTHWEST QUARTER OF THE NORTHWEST QUARTER OF SECTION 28, TOWNSHIP 24 NORTH, RANGE 6 EAST, W.M., DESCRIBED AS FOLLOWS:

BEGINNING AT A POINT ON THE NORTH LINE OF SAID SUBDIVISION 445.30 FEET EASTERLY OF THE NORTHWEST CORNER THEREOF;

THENCE SOUTH 01°39'07" WEST 686.76 FEET TO THE TRUE POINT OF BEGINNING; THENCE SOUTH 01°39'07" WEST 9.30 FEET; THENCE SOUTH 32'47'53" EAST 183.29 FEET;

THENCE SOUTH 88°20'58" EAST 212.25 FEET; THENCE NORTH 15'40'31" WEST 168.07 FEET; THENCE NORTH 88°20'58" WEST 265.87 FEET TO THE TRUE POINT OF BEGINNING.

MERIDIAN: NAD83 - 2011

BASIS OF BEARING:

N8816'54"W BETWEEN FOUND MONUMENTS ON NW INNESWOOD DRIVE

VERTICAL DATUM: NAVD 88

BENCH MARK:

LOT 3 THE WOODS AT ISSAQUAH DIVISION 4 VOL. 127, PGS. 35 & 36

LOT 5 THE WOODS AT ISSAQUAH DIVISION 4 VOL. 127, PGS. 35 & 36

FOUND REBAR & CAP --- LS #10117 0.1' S & 0.1' W

SDCB RIM=163.23

FOUND REBAR & CAP

THE WOODS AT ISSAQUAH FOUND 1" IRON PIPE

LS #10937 -0.3' N & 0.3' W

DIVISION 1 VOL. 110, PGS. 31–33

IE 24" CMP (SE)=151.93 IE 24" CMP (SW)=151.93

R=199.36

L=60.29'

- RIGHT TURN AHEAD SIGN

HOUSE #1055

GRAVEL DRIVEWAY

LOT 42 THE WOODS AT ISSAQUAH DIVISION 1 VOL. 110, PGS. 31–33

TOP OF MONUMENT IN CASE ON NW INNESWOOD DRIVE (SHOWN HEREON) ELEVATION = 166.71 (ESTABLISHED BY WSRN GPS NETWORK OBSERVATION)

LOT 4
THE WOODS AT ISSAQUAH
DIVISION 4
VOL. 127, PGS. 35 & 36

APPROVAL CONDITIONS

□ Reviewed and determined to be not applicable. □ Reviewed and determined to be not applicable.

☐ Reviewed and determined to be not applicable.

Land Development Manager Date ONLY SHEETS WITH AUTHORIZING SIGNATURES HAVE BEEN APPROVED FOR CONSTRUCTION

DESIGNED DRAWN CHECKED APPROVED

SHEET

CITY OF ISSAQUAH

(\$88°20'58"E DEED) \$88°16'54"E

S8816'54"E 75.68'

FOUND REBAR & CAP

LS #10937 -

LOT 2 THE WOODS AT ISSAQUAH DIVISION 4 VOL. 127, PGS. 35 & 36

LOT 44 THE WOODS AT ISSAQUAH DIVISION 1 VOL. 110, PGS. 31–33

0.1' N & 2.0' W

TOUND BEBAR & CAP

LS #10937

0.1' N & 2.0' W \

S01°43'11"W

NW CORNER OF

SW 1/4, NW 1/4 S. 28, T. 24 N., R. 6 E.

FOUND MONUMENT — IN CASE

RIM=152.45 IE 8" PVC (N)=136.15 —

IE 6" PVC (S)=136.35

IE 6" PVC (SW)=136.35


SDCB RIM=149.08

IE 21" CMP (E)=143.98 -IE 6" PVC (S)=144.78
IE 21" CMP (W)=143.98

SCALE 1" = 20'LEGEND: FOUND MONUMENT IN CASE FOUND REBAR & CAP FINISHED FLOOR ELEVATION WATER VALVE FIRE HYDRANT WATER METER IRRIGATION CONTROL VALVE SEWER MANHOLE CATCH BASIN SIGN POST - WOOD FENCE - SD - STORM LINE - s - s - SEWER LINE - w - WATER LINE COOC ROCKERY GAS METER CEDAR MAPLE WILLOW


INNESWOOD DRIVE TOPOGRAPHIC SURVEY

02/14/18 1"=20' JEF DBM DBM

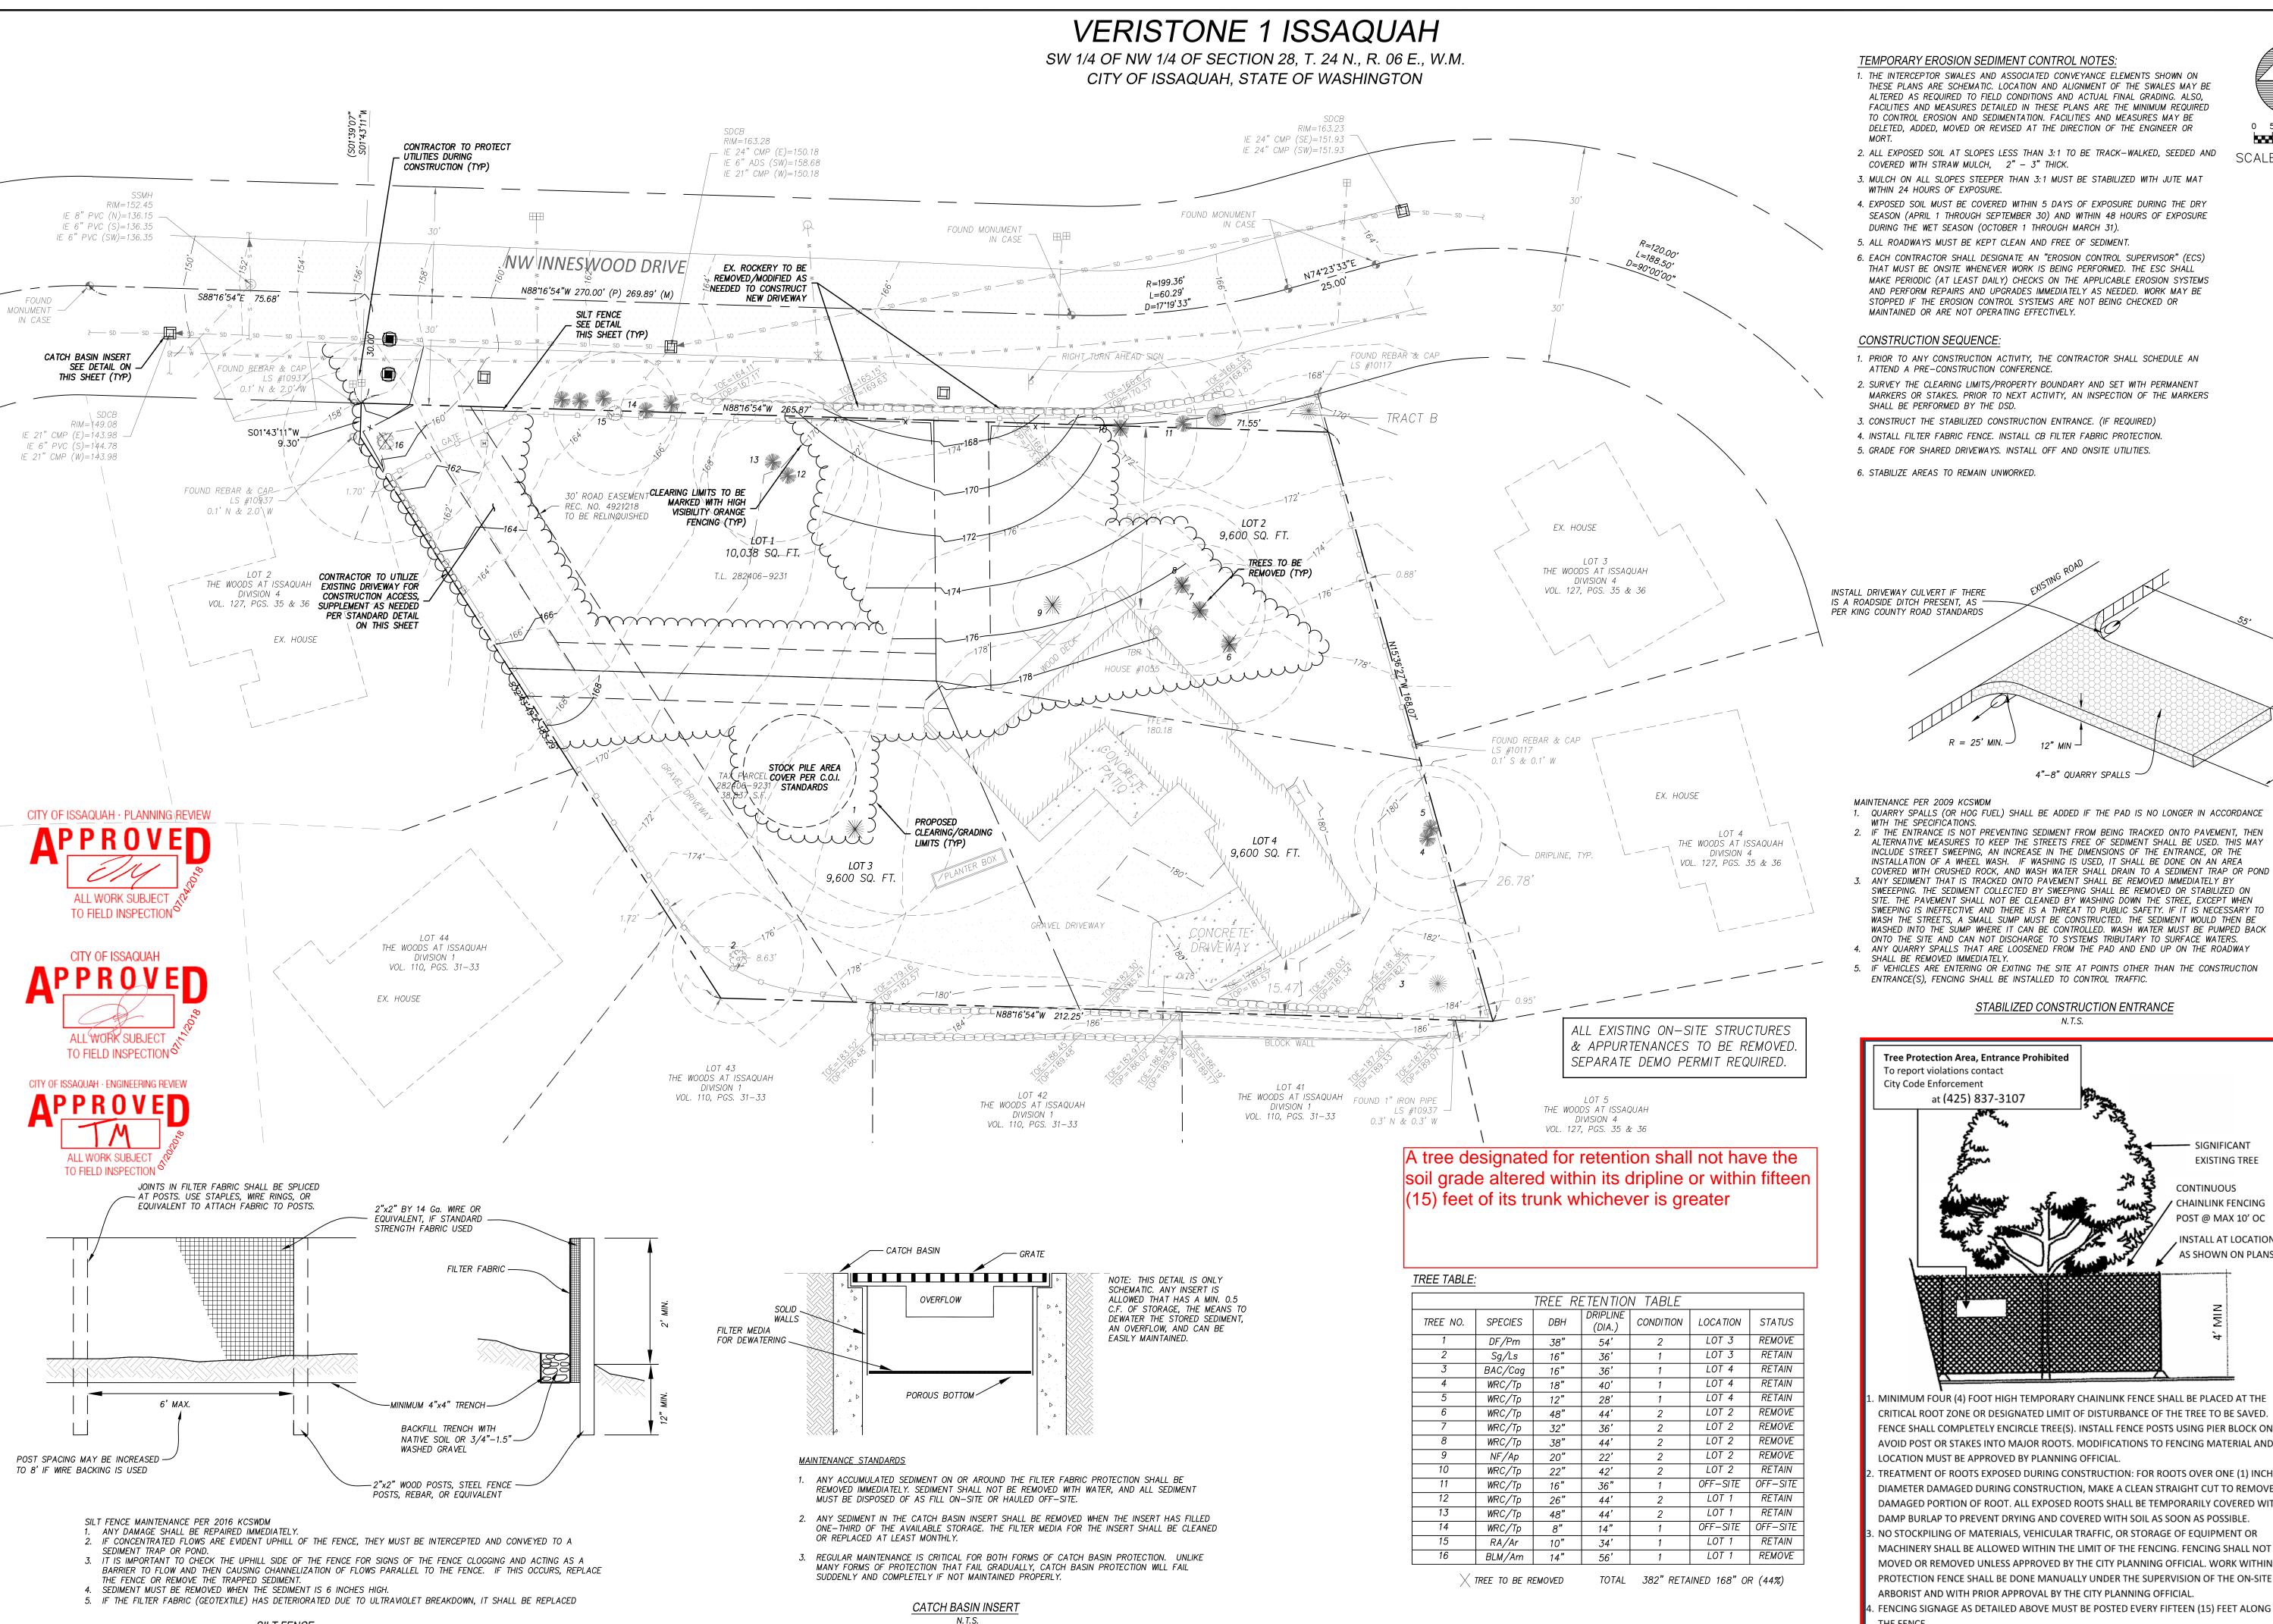


TEMPORARY EROSION SEDIMENT CONTROL NOTES

1. THE INTERCEPTOR SWALES AND ASSOCIATED CONVEYANCE ELEMENTS SHOWN ON THESE PLANS ARE SCHEMATIC. LOCATION AND ALIGNMENT OF THE SWALES MAY BE ALTERED AS REQUIRED TO FIELD CONDITIONS AND ACTUAL FINAL GRADING. ALSO, FACILITIES AND MEASURES DETAILED IN THESE PLANS ARE THE MINIMUM REQUIRED

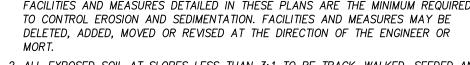

2. ALL EXPOSED SOIL AT SLOPES LESS THAN 3:1 TO BE TRACK-WALKED, SEEDED AND

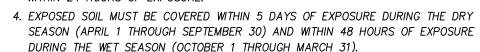


- 5. ALL ROADWAYS MUST BE KEPT CLEAN AND FREE OF SEDIMENT
- 6. EACH CONTRACTOR SHALL DESIGNATE AN "EROSION CONTROL SUPERVISOR" (ECS) THAT MUST BE ONSITE WHENEVER WORK IS BEING PERFORMED. THE ESC SHALL MAKE PERIODIC (AT LEAST DAILY) CHECKS ON THE APPLICABLE EROSION SYSTEMS AND PERFORM REPAIRS AND UPGRADES IMMEDIATELY AS NEEDED. WORK MAY BE STOPPED IF THE EROSION CONTROL SYSTEMS ARE NOT BEING CHECKED OR MAINTAINED OR ARE NOT OPERATING EFFECTIVELY.

CONSTRUCTION SEQUENCE:

- 1. PRIOR TO ANY CONSTRUCTION ACTIVITY, THE CONTRACTOR SHALL SCHEDULE AN ATTEND A PRE-CONSTRUCTION CONFERENCE.
- 2. SURVEY THE CLEARING LIMITS/PROPERTY BOUNDARY AND SET WITH PERMANENT MARKERS OR STAKES. PRIOR TO NEXT ACTIVITY, AN INSPECTION OF THE MARKERS SHALL BE PERFORMED BY THE DSD.
- 3. CONSTRUCT THE STABILIZED CONSTRUCTION ENTRANCE. (IF REQUIRED)
- 4. INSTALL FILTER FABRIC FENCE. INSTALL CB FILTER FABRIC PROTECTION.
- 5. GRADE FOR SHARED DRIVEWAYS. INSTALL OFF AND ONSITE UTILITIES.


6. STABILIZE AREAS TO REMAIN UNWORKED.

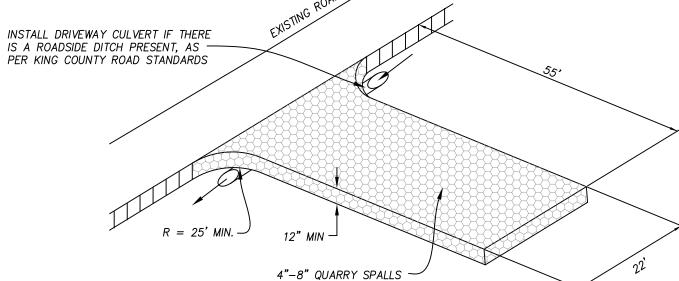

MAINTENANCE PER 2009 KCSWDM

- 1. QUARRY SPALLS (OR HOG FUEL) SHALL BE ADDED IF THE PAD IS NO LONGER IN ACCORDANCE WITH THE SPECIFICATIONS.
- 2. IF THE ENTRANCE IS NOT PREVENTING SEDIMENT FROM BEING TRACKED ONTO PAVEMENT. THEN ALTERNATIVE MEASURES TO KEEP THE STREETS FREE OF SEDIMENT SHALL BE USED. THIS MAY INCLUDE STREET SWEEPING, AN INCREASE IN THE DIMENSIONS OF THE ENTRANCE, OR THE INSTALLATION OF A WHEEL WASH. IF WASHING IS USED, IT SHALL BE DONE ON AN AREA COVERED WITH CRUSHED ROCK, AND WASH WATER SHALL DRAIN TO A SEDIMENT TRAP OR POND SWEEPING. THE SEDIMENT COLLECTED BY SWEEPING SHALL BE REMOVED OR STABILIZED ON SITE. THE PAVEMENT SHALL NOT BE CLEANED BY WASHING DOWN THE STREE, EXCEPT WHEN SWEEPING IS INEFFECTIVE AND THERE IS A THREAT TO PUBLIC SAFETY. IF IT IS NECESSARY TO WASH THE STREETS, A SMALL SUMP MUST BE CONSTRUCTED. THE SEDIMENT WOULD THEN BE WASHED INTO THE SUMP WHERE IT CAN BE CONTROLLED. WASH WATER MUST BE PUMPED BACK
- ONTO THE SITE AND CAN NOT DISCHARGE TO SYSTEMS TRIBUTARY TO SURFACE WATERS. ANY QUARRY SPALLS THAT ARE LOOSENED FROM THE PAD AND END UP ON THE ROADWAY SHALL BE REMOVED IMMEDIATELY.
- 5. IF VEHICLES ARE ENTERING OR EXITING THE SITE AT POINTS OTHER THAN THE CONSTRUCTION ENTRANCE(S), FENCING SHALL BE INSTALLED TO CONTROL TRAFFIC.

STABILIZED CONSTRUCTION ENTRANCE

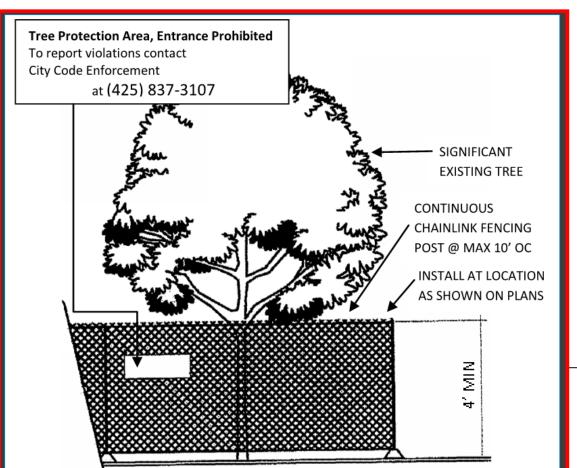

MINIMUM FOUR (4) FOOT HIGH TEMPORARY CHAINLINK FENCE SHALL BE PLACED AT THE CRITICAL ROOT ZONE OR DESIGNATED LIMIT OF DISTURBANCE OF THE TREE TO BE SAVED. FENCE SHALL COMPLETELY ENCIRCLE TREE(S). INSTALL FENCE POSTS USING PIER BLOCK ONLY AVOID POST OR STAKES INTO MAJOR ROOTS. MODIFICATIONS TO FENCING MATERIAL AND LOCATION MUST BE APPROVED BY PLANNING OFFICIAL.

DIAMETER DAMAGED DURING CONSTRUCTION, MAKE A CLEAN STRAIGHT CUT TO REMOVE DAMAGED PORTION OF ROOT. ALL EXPOSED ROOTS SHALL BE TEMPORARILY COVERED WITH DAMP BURLAP TO PREVENT DRYING AND COVERED WITH SOIL AS SOON AS POSSIBLE. . NO STOCKPILING OF MATERIALS, VEHICULAR TRAFFIC, OR STORAGE OF EQUIPMENT OR MACHINERY SHALL BE ALLOWED WITHIN THE LIMIT OF THE FENCING. FENCING SHALL NOT B MOVED OR REMOVED UNLESS APPROVED BY THE CITY PLANNING OFFICIAL. WORK WITHIN PROTECTION FENCE SHALL BE DONE MANUALLY UNDER THE SUPERVISION OF THE ON-SITE ARBORIST AND WITH PRIOR APPROVAL BY THE CITY PLANNING OFFICIAL. . FENCING SIGNAGE AS DETAILED ABOVE MUST BE POSTED EVERY FIFTEEN (15) FEET ALONG

> TREE PROTECTION **FENCING DETAIL**

17518 02/14/18 1"=20' **ESIGNED** NEM LFM DRAWN CHECKED NEM APPROVED

SCALE 1" = 20'

02/14/18

DRIV *QO*

CJA